



NO.	DESCRIPTION	BY	DATE
1	Construction Set	B/C	4/15/2021
2	Construction Set	B/C	4/26/2021
3	Construction Set	B/C	5/10/2021
4	Construction Set	B/C	6/11/2021

SHEET TITLE:
Main Floor Plan

PROJECT DESCRIPTION:
Park Home (1952-47th Street)
L1, B1, D4 The Villas
Ammon, Idaho

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1306 East 2500 North
North Logan, Utah 84341
Phone: 435-757-2906

JOB #
21020


SCALE:
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SHEET:
2


SHEAR WALL SCHEDULE

TYPE	EDGE NAIL SPACING	FIELD NAIL SPACING	EDGE STAPLE SPACING	FIELD STAPLE SPACING
A	6"	12"	3"	12"
B	4"	12"	2"	12"
C	3"	12"	NOT PERMITTED	NOT PERMITTED
D	2"	12"	NOT PERMITTED	NOT PERMITTED

- NOTES:
- 1) SHEETING NAILS ARE TO BE 8d COMMON NAILS
 - 2) ALL PANEL EDGES ARE TO HAVE BLOCKING WITH EDGE NAILING
 - 3) TYPE C AND D WALLS ARE TO HAVE 3" NOMINAL FRAMING AT ALL PANEL EDGES.
 - 4) UNLESS NOTED OTHERWISE SHEET ALL EXTERIOR WALLS AS TYPE "A" WALLS
 - 5) STAPLES SHALL BE 16 GAGE AND HAVE A MINIMUM CROWN WIDTH OF 7/16" AND SHALL BE INSTALLED WITH THEIR CROWN PARALLEL TO THE LONG DIMENSION OF THE FRAMING MEMBERS.
 - 6) STAPLES SHALL HAVE 1" MINIMUM PENETRATION IN FRAMING

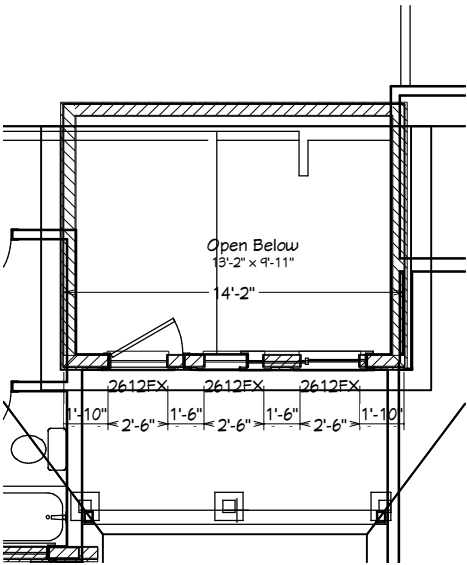

DORMER PLAN

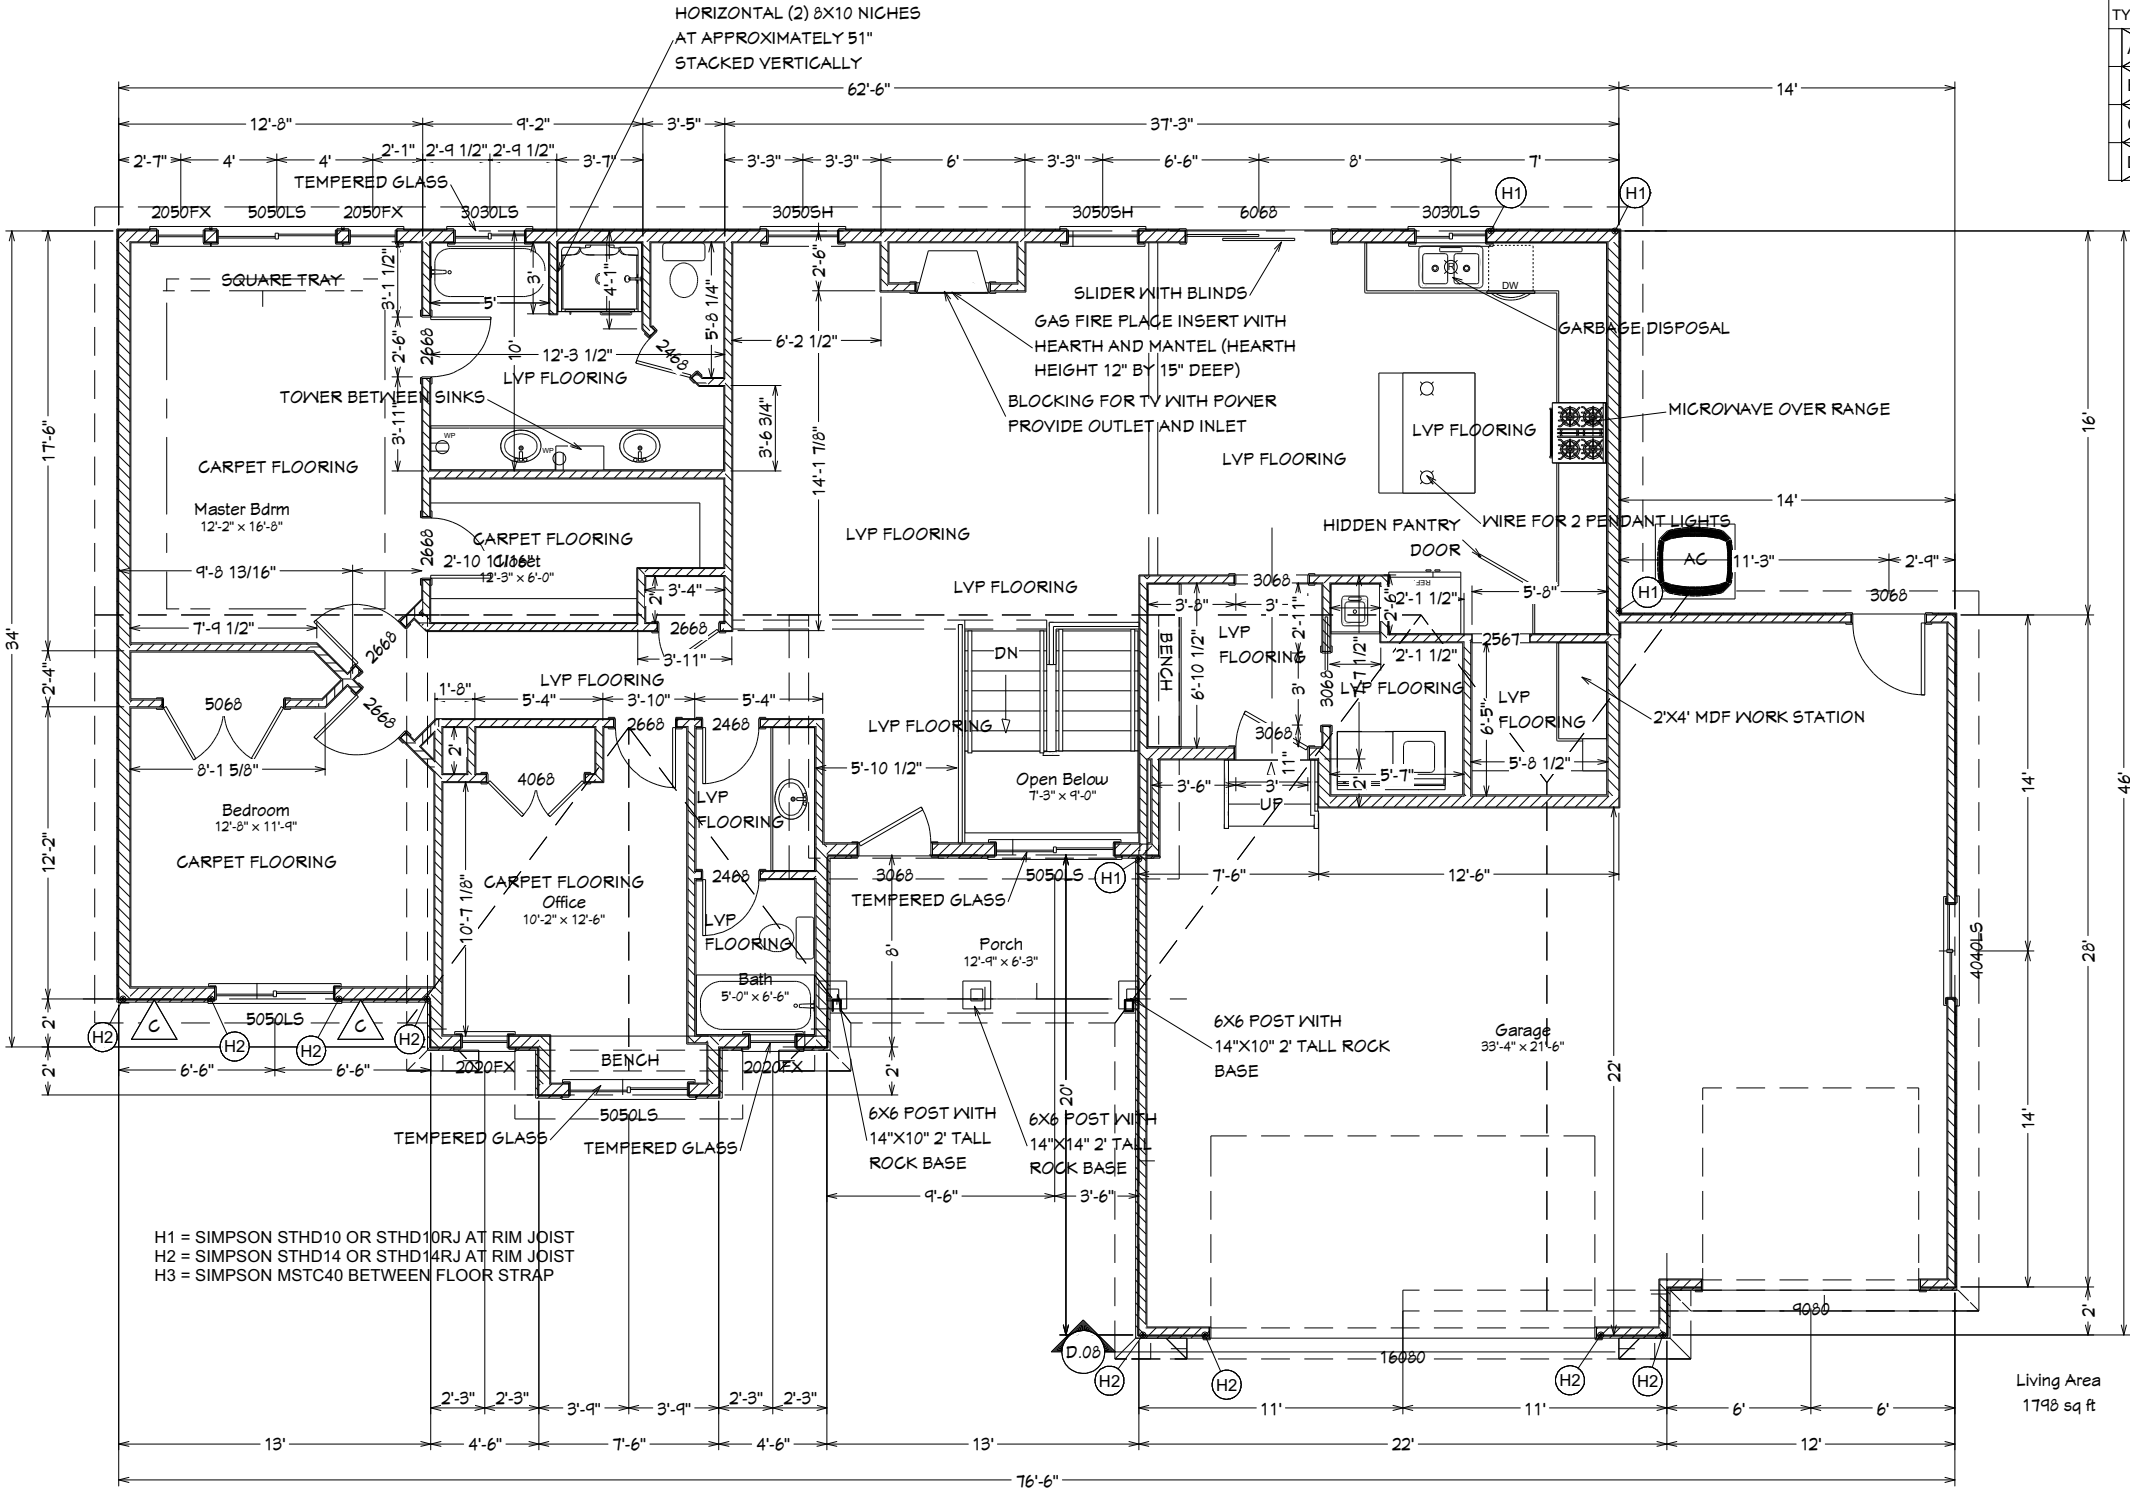


MAIN FLOOR PLAN

Main floor:	1798 sf
Foundation:	1766 sf
Basement:	1569 sf
Basement finished:	1426 sf
Front Porch:	78 sf
Garage:	877 sf



Professional Stamp
For Structural Design
Only

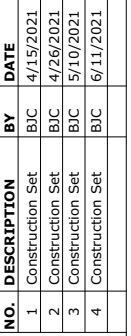

SHEET TITLE:
Foundation Plan

PROJECT DESCRIPTION:
Park Home (1952 47TH Street)
L11, B9, D4 The Villas
Ammon, Idaho

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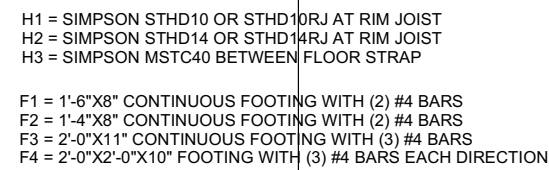
JOB #
21020

SCALE:

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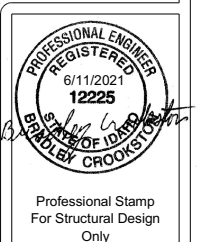
SHEET:

3





FOUNDATION PLAN

Main floor:	1798 sf
Foundation:	1766 sf
Basement:	1569 sf
Basement finished:	1426 sf
Front Porch:	78 sf
Garage:	877 sf



Contractors/Sub-Contractors to verify all finish work with contract. Plans as drawn may represent future options and possible finished layout. Extent of Finish as dictated by Sales Contract supersedes drawing representations.

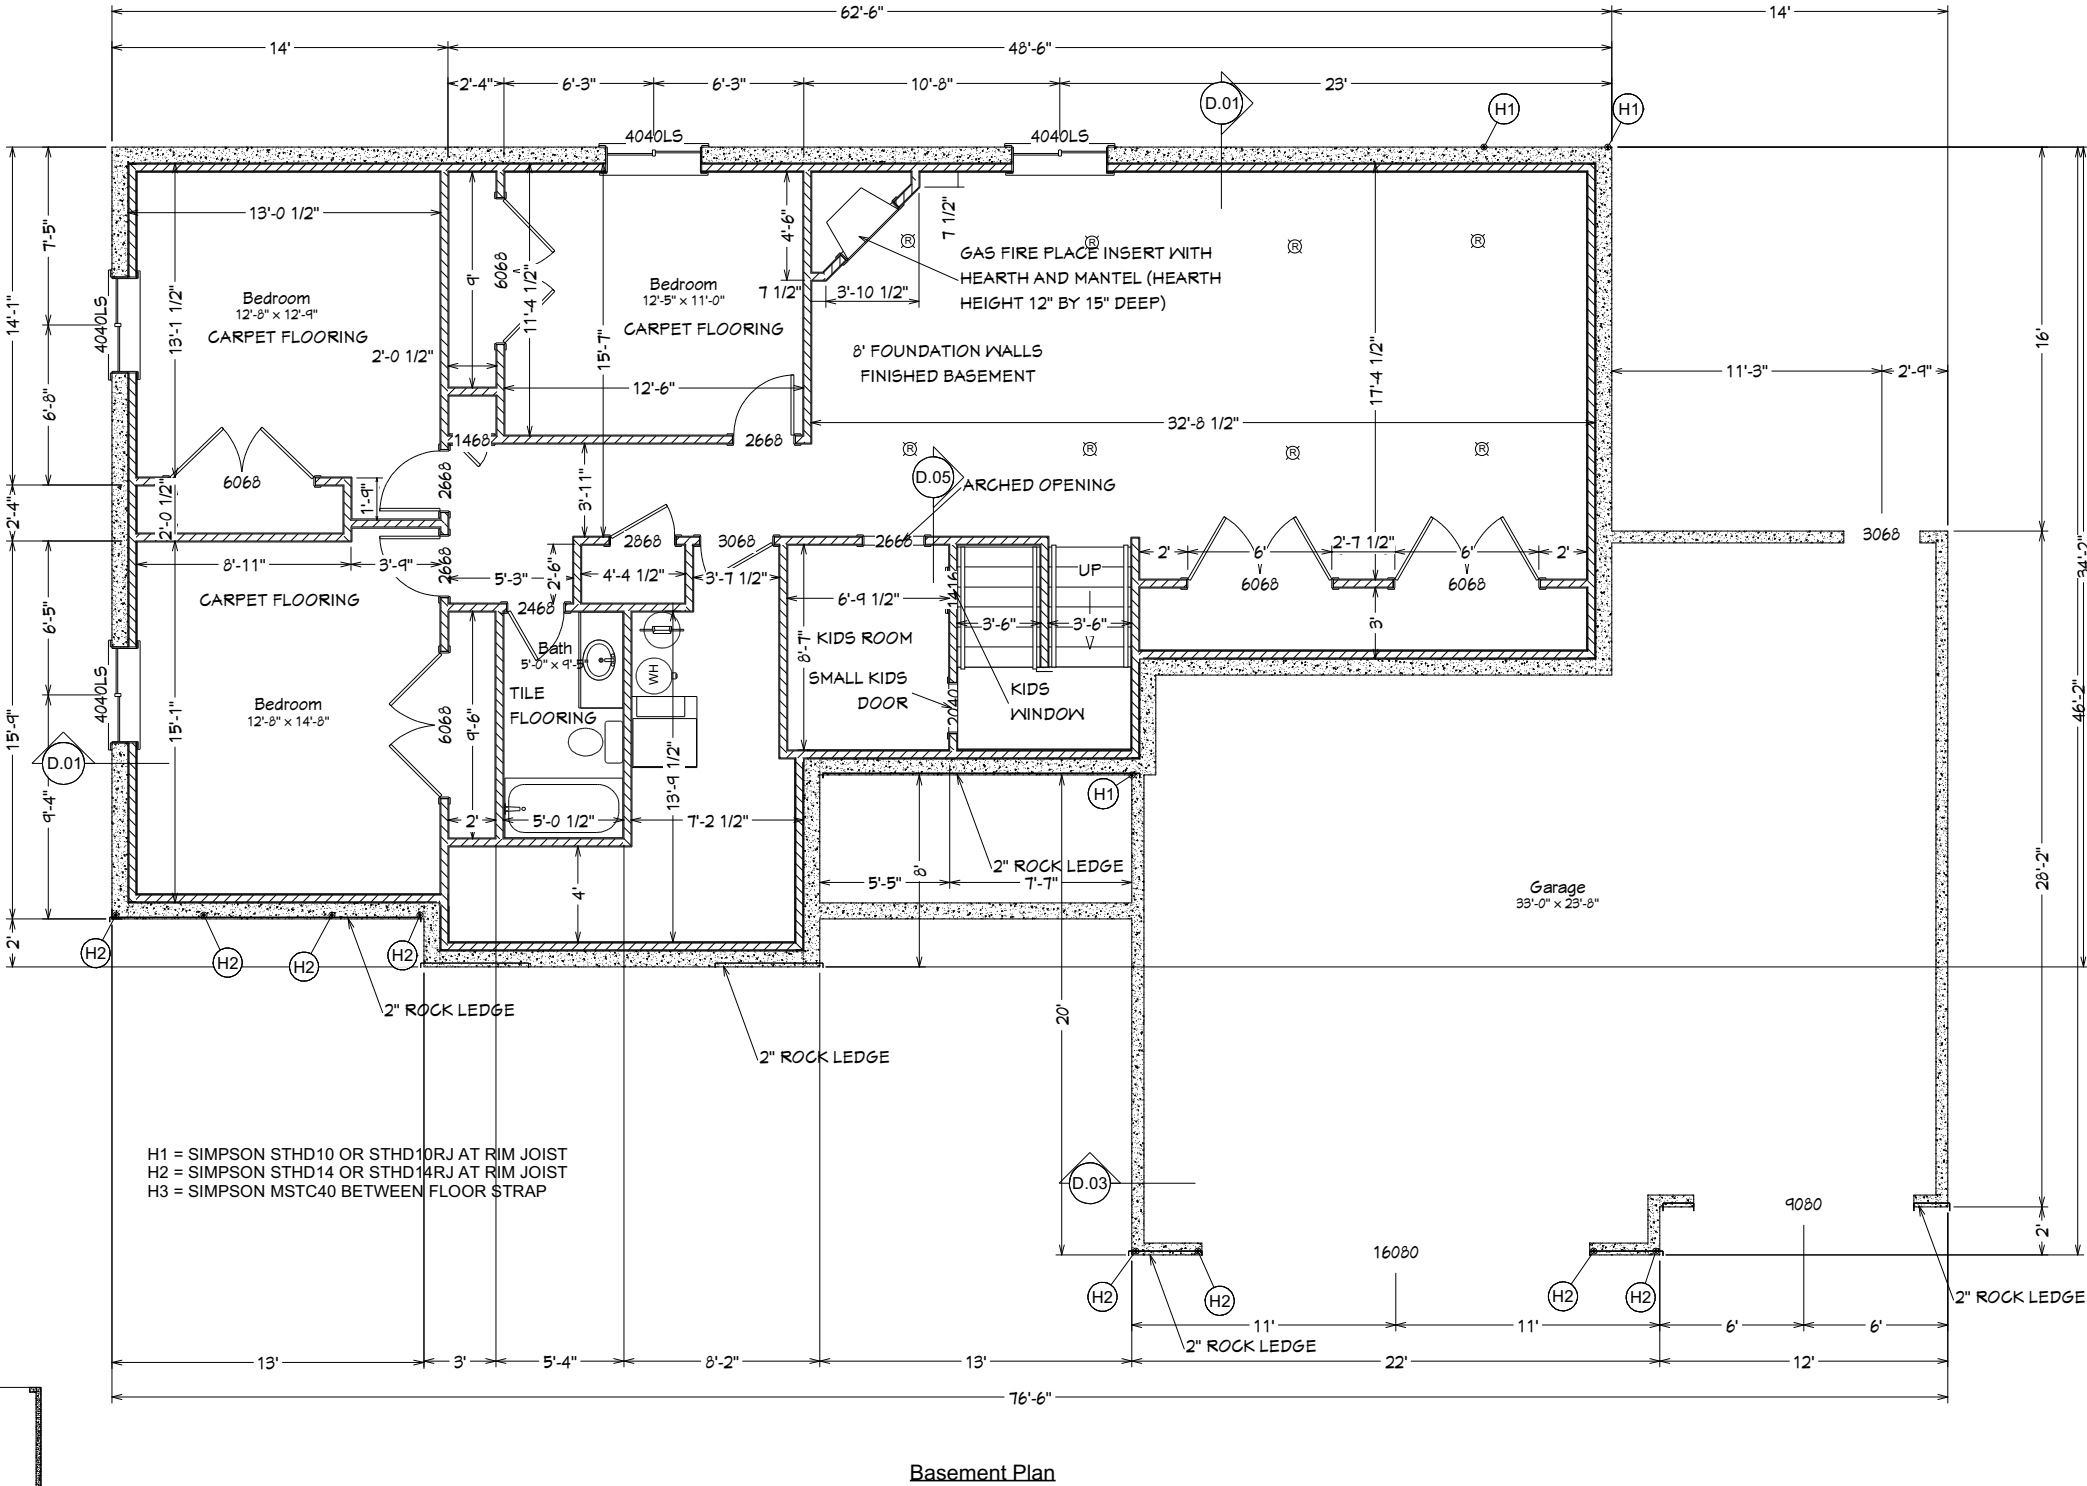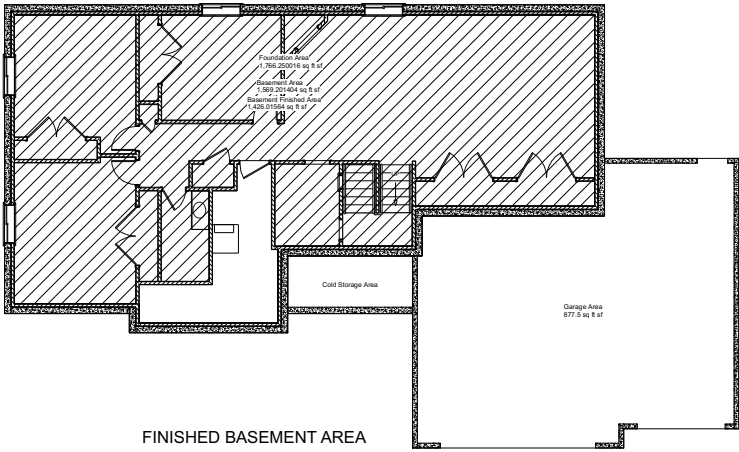

Basement Plan

Main floor:	1798 sf
Foundation:	1766 sf
Basement:	1569 sf
Basement finished:	1426 sf
Front Porch:	78 sf
Garage:	877 sf

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1	Construction Set	B/C	4/15/2021
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4	Construction Set	B/C	6/11/2021

SHEET TITLE: Basement Plan	PROJECT DESCRIPTION: Park Home (1952 47TH Street) L1, B1, D4 The Villas Ammon, Idaho
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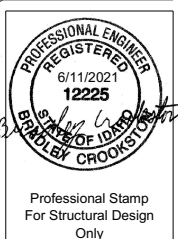
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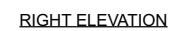
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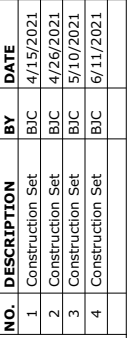
SCALE:
1/4" = 1'

SHEET:
4



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SHEET TITLE:
Front & Right Elevations

PROJECT DESCRIPTION:
Park Home (1952 47TH Street)
L11, B9, D4 The Villas
Ammon, Idaho

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SCALE:

$$1/4'' = 1'$$

SHEET:

5




BACK ELEVATION



LEFT ELEVATION

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Main floor: 1798 sf
Foundation: 1766 sf
Basement: 1569 sf
Basement finished: 1426 sf
Front Porch: 78 sf
Garage: 877 sf

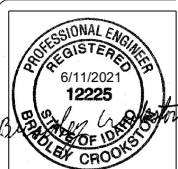

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1	Construction Set	B/C	4/15/2021
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3	Construction Set	B/C	5/10/2021
4	Construction Set	B/C	6/11/2021

SHEET TITLE:
Back & Left Elevations
PROJECT DESCRIPTION:
Park Home (1952-47TH Street)
L11, B9, D4 The Villas
Ammon, Idaho

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JOB #
21020
SCALE:
1/4" = 1'
SHEET:
6



NO.	DESCRIPTION	BY	DATE
1	Construction Set	B/C	4/15/2021
2	Construction Set	B/C	4/26/2021
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4	Construction Set	B/C	6/11/2021

SHEET TITLE:
Sections & Details

PROJECT DESCRIPTION:
Park Home (1952 47TH Street)
L1, B5, D4 The Villas
Ammon, Idaho

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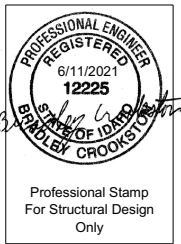
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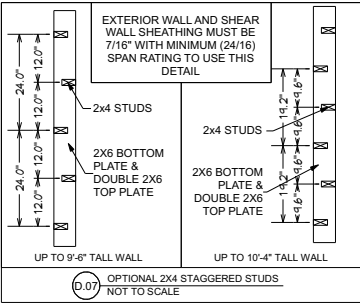
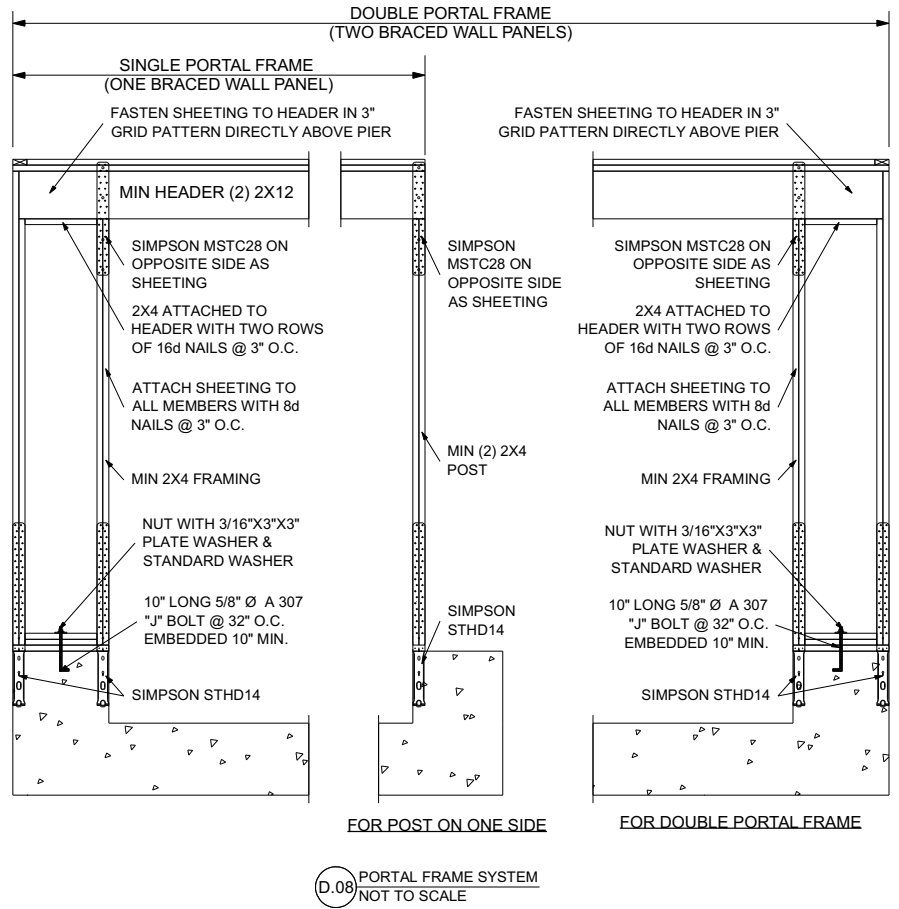
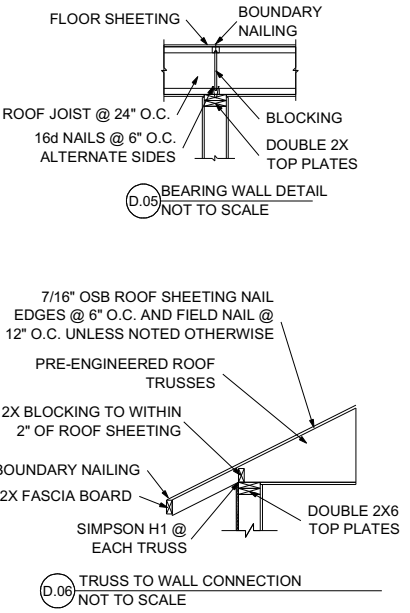
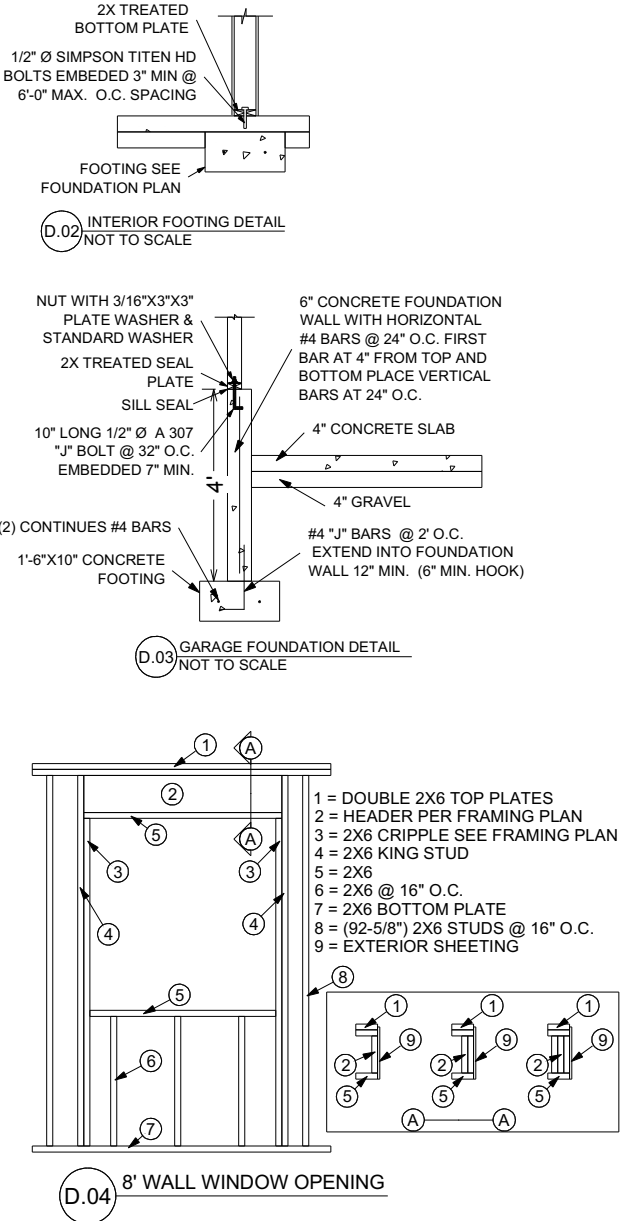
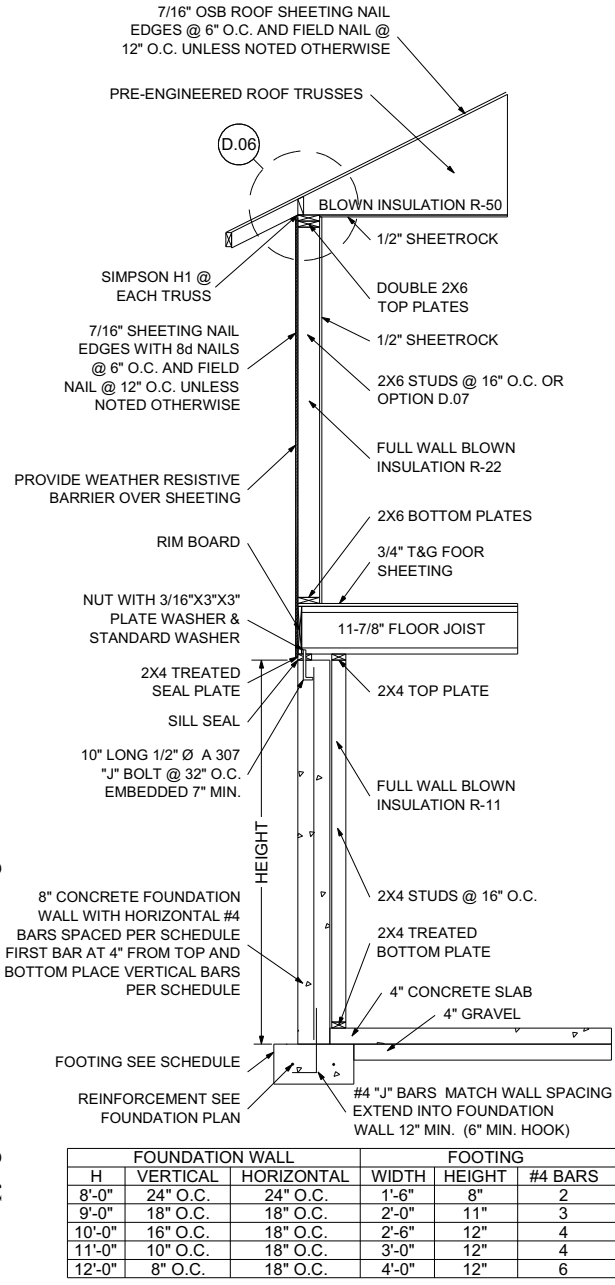
SCALE:
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SHEET:
7



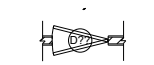
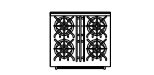
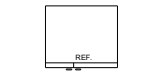
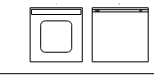
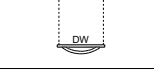

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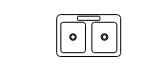
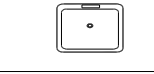
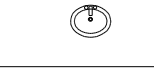











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PLAN SYMBOLS

	WINDOW OPENING
	DOOR OPENING
	DOUBLE SWING DOOR OPENING
	COOK RANGE WITH OVEN
	REFRIGERATOR
	LAUNDRY WASHER & DRYER
	DISH WASHER
	WALL OVEN

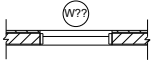	DOUBLE KITCHEN SINK
	SINGLE UTILITY SINK
	BATHROOM SINK
	PEDESTAL SINK
	TOILET
	BATH TUB WITH SHOWER
	LARGE SOAKER TUB
	SHOWER
	WATER HEATER
	FORCED AIR FURNACE
	INSERT FIRE PLACE
	WOOD STOVE

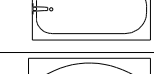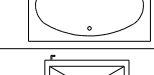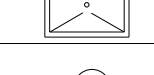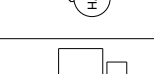FASTENING SCHEDULE

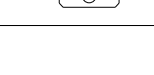
CONNECTION	FASTENING (a), (m)	LOCATION
1. Joist to sill or girder	3 - 8d common (2-1/2" × 0.131")	toenail
	3 - 3" × 0.131" nails	
	3 - 3" 14 gage staples	
2. Bridging to joist	2 - 8d common (2-1/2" × 0.131")	toenail each end
	2 - 3" × 0.131" nails	
	2 - 3" 14 gage staples	
3. 1" × 6" subfloor or less to each joist	2 - 8d common (2-1/2" × 0.131")	face nail
4. Wider than 1" × 6" subfloor to each joist	3 - 8d common (2-1/2" × 0.131")	face nail
5. 2" subfloor to joist or girder	2 - 16d common (3-1/2" × 0.162")	blind and face nail
6. Sole plate to joist or blocking	16d (3-1/2" × 0.135") at 16" o.c.	typical face nail
Sole plate to joist or blocking at braced Wall panel	3" × 0.131" nails at 8" o.c.	braced wall panels
	3" 14 gage staples at 12" o.c.	
	3- 16d (3-1/2" × 0.135") at 16" o.c.	
	4 - 3" × 0.131" nails at 16" o.c.	
7. Top plate to stud	4 - 3" 14 gage staples at 16" o.c.	end nail
	2 - 16d common (3-1/2" × 0.162")	
	3 - 3" × 0.131" nails	
8. Stud to sole plate	3 - 3" 14 gage staples	toenail
	4 - 8d common (2-1/2" × 0.131")	
	4 - 3" × 0.131" nails	
9. Double studs	3 - 3" 14 gage staples	end nail
	2 - 16d common (31/2" × 0.162")	
	3 - 3" × 0.131" nails	
	3 - 3" 14 gage staples	
10. Double top plates	16d (3-1/2" × 0.135") at 24" o.c.	face nail
	3" × 0.131" nail at 8" o.c.	
	3" 14 gage staple at 8" o.c.	
Double top plates	16d (3-1/2" × 0.135") at 16" o.c.	typical face nail
	3" × 0.131" nail at 12" o.c.	
	3" 14 gage staple at 12" o.c.	
	3 - 16d common (3-1/2" × 0.162")	
11. Blocking between joists or rafters to top plate	8 - 16d common (3-1/2" × 0.162")	lap splice
	12 - 3" × 0.131" nails	
	12 - 3" 14 gage staples	
12. Rim joist to top plate	3 - 8d common (2-1/2" × 0.131")	toenail
	3 - 3" × 0.131" nails	
	3 - 3" 14 gage staples	
13. Top plates, laps and intersections	8d (2-1/2" × 0.131") at 6" o.c.	toenail
	3" × 0.131" nail at 6" o.c.	
	3" 14 gage staple at 6" o.c.	
14. Continuous header, two pieces	2 - 16d common (3-1/2" × 0.162")	face nail
	3 - 3" × 0.131" nails	
	3 - 3" 14 gage staples	
15. Ceiling joists to plate	16d common (3-1/2" × 0.162")	16" o.c. along edge
	3 - 8d common (2-1/2" × 0.131")	
	5 - 3" × 0.131" nails	
16. Continuous header to stud	5 - 3" 14 gage staples	toenail
	4 - 8d common (2-1/2" × 0.131")	
	3 - 16d common (3-1/2" × 0.162") min., Table 2308.10.4.1	
17. Ceiling joists, laps over partitions (see Section 2308.10.4.1, Table 2308.10.4.1)	4 - 3" × 0.131" nails	face nail
	4 - 3" 14 gage staples	
	3 - 16d common (3-1/2" × 0.162") minimum, Table 2308.10.4.1	
18. Ceiling joists to parallel rafters (see Section 2308.10.4.1, Table 2308.10.4.1)	4 - 3" × 0.131" nails	face nail
	4 - 3" 14 gage staples	
	3 - 16d common (3-1/2" × 0.162") minimum, Table 2308.10.4.1	
19. Rafter to plate (see Section 2308.10.1, Table 2308.10.1)	3 - 8d common (2-1/2" × 0.131")	toenail
	3 - 3" × 0.131" nails	
	3 - 3" 14 gage staples	

CONNECTION	FASTENING (a), (m)	LOCATION
20. 1" diagonal brace to each stud and plate	2 - 8d common (2-1/2" × 0.131")	face nail
	2 - 3" × 0.131" nails	
	3 - 3" 14 gage staples	
21. 1" × 8" sheathing to each bearing	3 - 8d common (2-1/2" × 0.131")	face nail
22. Wider than 1" × 8" sheathing to each bearing	3 - 8d common (2-1/2" × 0.131")	face nail
23. Built-up corner studs	16d common (3-1/2" × 0.162")	24" o.c.
	3" × 0.131" nails	
	3" 14 gage staples	
24. Built-up girder and beams	20d common (4" × 0.192") 32" o.c.	face nail at top and bottom staggered on opposite sides
	3" × 0.131" nail at 24" o.c.	
	3" 14 gage staple at 24" o.c.	
	2 - 20d common (4" × 0.192")	
25. 2" planks	3 - 3" × 0.131" nails	face nail at ends and at each splice
	3 - 3" 14 gage staples	
	2 - 20d common (4" × 0.192")	
	3 - 3" × 0.131" nails	
26. Collar tie to rafter	3 - 3" 14 gage staples	face nail
	16d common (3-1/2" × 0.162")	
	3 - 10d common (3" × 0.148")	
27. Jack rafter to hip	4 - 3" × 0.131" nails	toenail
	4 - 3" 14 gage staples	
	4 - 3" × 0.131" nails	
	4 - 3" 14 gage staples	
28. Roof rafter to 2-by ridge beam	2 - 16d common (3-1/2" × 0.162")	toenail
	3 - 3" × 0.131" nails	
	3 - 3" 14 gage staples	
	2 -16d common (3-1/2" × 0.162")	
29. Joist to band joist	3 - 3" × 0.131" nails	face nail
	3 - 3" 14 gage staples	
	3 - 16d common (3-1/2" × 0.162")	
	4 - 3" × 0.131" nails	
30. Ledger strip	4 - 3" × 0.131" nails	face nail at each joist
	4 - 3" 14 gage staples	
	3 - 16d common (3-1/2" × 0.162")	
	4 - 3" × 0.131" nails	
31. Wood structural panels and particleboard (b) Subfloor, roof and wall sheathing (to framing)	4 - 3" 14 gage staples	6d (c), 1 2-3/8" × 0.113" nail (n)
	1/2" and less	
	19/32" to 3/4"	
Single floor (combination subfloor-underlayment to framing)		8d (d) or 6d (e) 2-3/8" × 0.113" nail (p) 2" 16 gage staple (p)
32. Panel siding (to framing)	7/8" to 1"	8d (c) 10d (d) or 8d (e) 6d (e) 8d (e) 10d (d) or 8d (e)
	11/8" to 11/4"	
	3/4" and less	
	7/8" to 1"	
33. Fiberboard sheathing (g)	11/8" to 11/4"	No. 11 gage roofing nail (h) 6d common nail (2" × 0.113") No. 16 gage staple (i) No. 11 gage roofing nail (h) 8d common nail (2-1/2" × 0.131") No. 16 gage staple (i)
	1/2" or less	
	5/8"	
	1/2"	
34. Interior paneling	25/32"	4d (j) 6d (k)
	1/4"	
	3/8"	

a. Common or box nails are permitted to be used except where otherwise stated.
b. Nails spaced at 6 inches on center at edges, 12 inches at intermediate supports except 6 inches at supports where spans are 48 inches or more. For nailing of wood structural panel and particleboard diaphragms and shear walls, refer to Section 2305. Nails for wall sheathing are permitted to be common, box or casing.
c. Common or deformed shank (6d - 2" × 0.113"; 8d - 21/2" × 0.131"; 10d - 3" × 0.148").
d. Common (6d - 2" × 0.113"; 8d - 21/2" × 0.131"; 10d - 3" × 0.148").
e. Deformed shank (6d - 2" × 0.113"; 8d - 21/2" × 0.131"; 10d - 3" × 0.148").
f. Corrosion-resistant siding (6d - 17/8" × 0.106"; 8d - 23/8" × 0.128") or casing (6d - 2" × 0.099"; 8d - 21/2" × 0.113") nail.
g. Fasteners spaced 3 inches on center at exterior edges and 6 inches on center at intermediate supports, when used as structural sheathing. Spacing shall be 6 inches on center on the edges and 12 inches on center at intermediate supports for nonstructural applications.
h. Corrosion-resistant roofing nails with 7/16-inch-diameter head and 1-1/2-inch length for 1/2-inch sheathing and 1-3/4-inch length for 25/32-inch sheathing.

i. Corrosion-resistant staples with nominal 7/16-inch crown or 1-inch crown and 1-1/4-inch length for 1/2-inch sheathing and 1-inch length for 25/32-inch sheathing. Panel supports at 16 inches (20 inches if strength axis in the long direction of the panel, unless otherwise marked).
j. Casing (1-1/2" × 0.080") or finish (1-1/2" × 0.072") nails spaced 6 inches on panel edges, 12 inches at intermediate supports.
k. Panel supports at 24 inches. Casing or finish nails spaced 6 inches on panel edges, 12 inches at intermediate supports.
l. For roof sheathing applications, 8d nails (21/2" × 0.113") are the minimum required for wood structural panels.
m. Staples shall have a minimum crown width of 7/16 inch.
n. For roof sheathing applications, fasteners spaced 4 inches on center at edges, 8 inches at intermediate supports.
o. Fasteners spaced 4 inches on center at edges, 8 inches at intermediate supports for subfloor and wall sheathing and 3 inches on center at edges, 6 inches at intermediate supports for roof sheathing.
p. Fasteners spaced 4 inches on center at edges, 8 inches at intermediate supports.

Main floor: 1798 sf
Foundation: 1766 sf
Basement: 1569 sf
Basement finished: 1426 sf
Front Porch: 78 sf
Garage: 877 sf

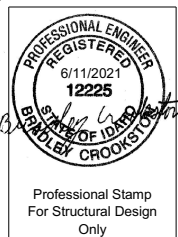

Contractors/Sub-Contractors to verify all finish work with contract. Plans as drawn may represent future options and possible finished layout. Extent of Finish as dictated by Sales Contract supersedes drawing representations.




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2	Construction Set	B/C	4/26/2021
3	Construction Set	B/C	5/10/2021
4	Construction Set	B/C	6/11/2021

SHEET TITLE: Nailing Schedule	PROJECT DESCRIPTION: Park Home (1952-47TH Street) L1, B5, D4 The Villas Ammon, Idaho
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IF DRAWINGS ARE NOT STAMPED AND SIGNED THEY ARE TO BE CONSIDERED PRELIMINARY NOT FOR CONSTRUCTION OR PERMIT. THESE DRAWINGS ARE ONLY TO BE USED FOR THE LOCATION SPECIFIED. IF SUBMITTED FOR ANY OTHER LOCATION PLEASE CONTACT CROOKSTON CUSTOM DESIGNS.

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North Logan, Utah 84341
Phone: 435-757-2906


JOB #
21020
SCALE:
1/4" = 1'
SHEET:
8

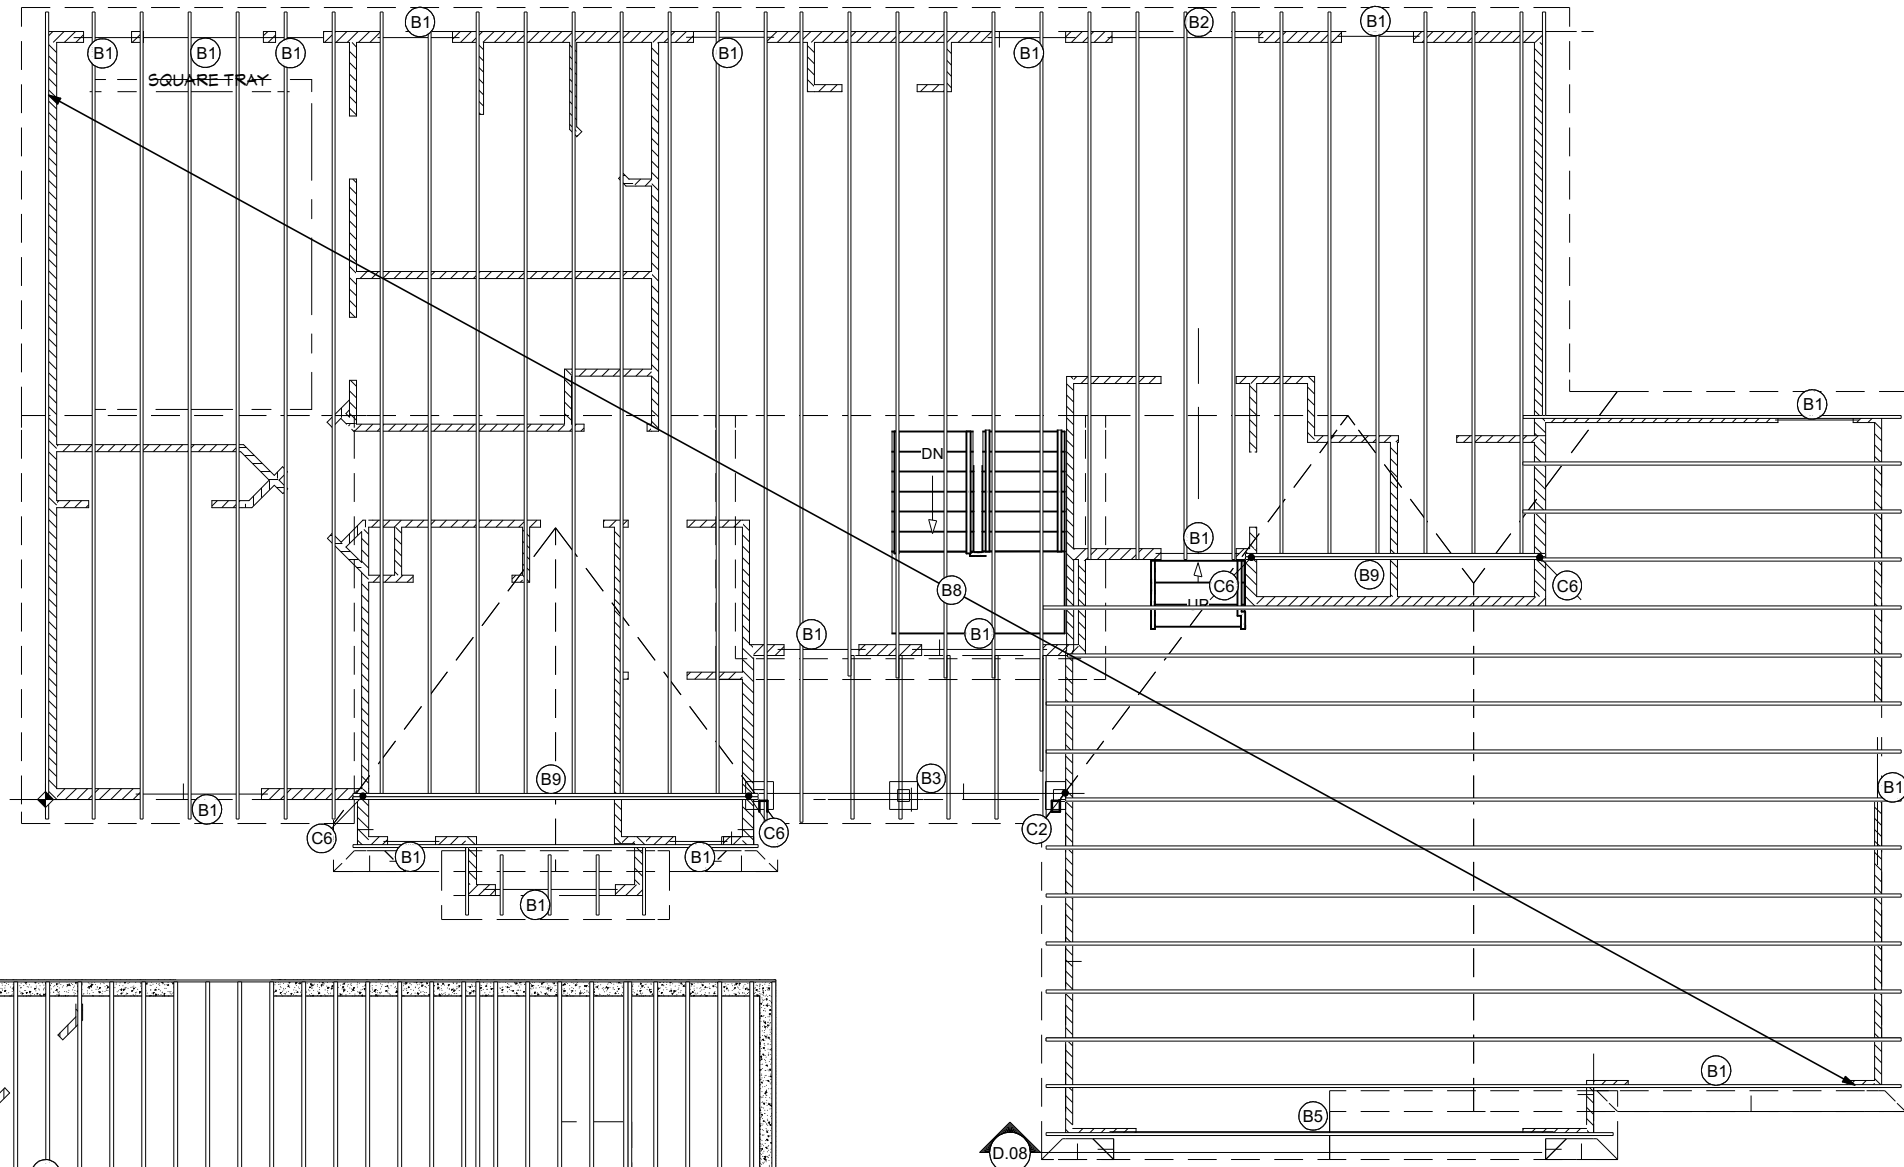

MAIN FLOOR FRAMING PLAN

C1	(2) 2X4
C2	(3) 2X4
C3	(4) 2X4
C4	(5) 2X4
C5	(2) 2X6
C6	(3) 2X6
C7	(4) 2X6
C8	(5) 2X6


Main floor:	1798 sf
Foundation:	1766 sf
Basement:	1569 sf
Basement finished:	1426 sf
Front Porch:	78 sf
Garage:	877 sf

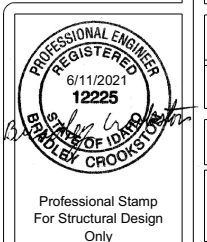


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Park Home (1952 47TH Street)
L11, B9, D4 The Villas
Ammon, Idaho

Zoning: R-1
Bonneville County

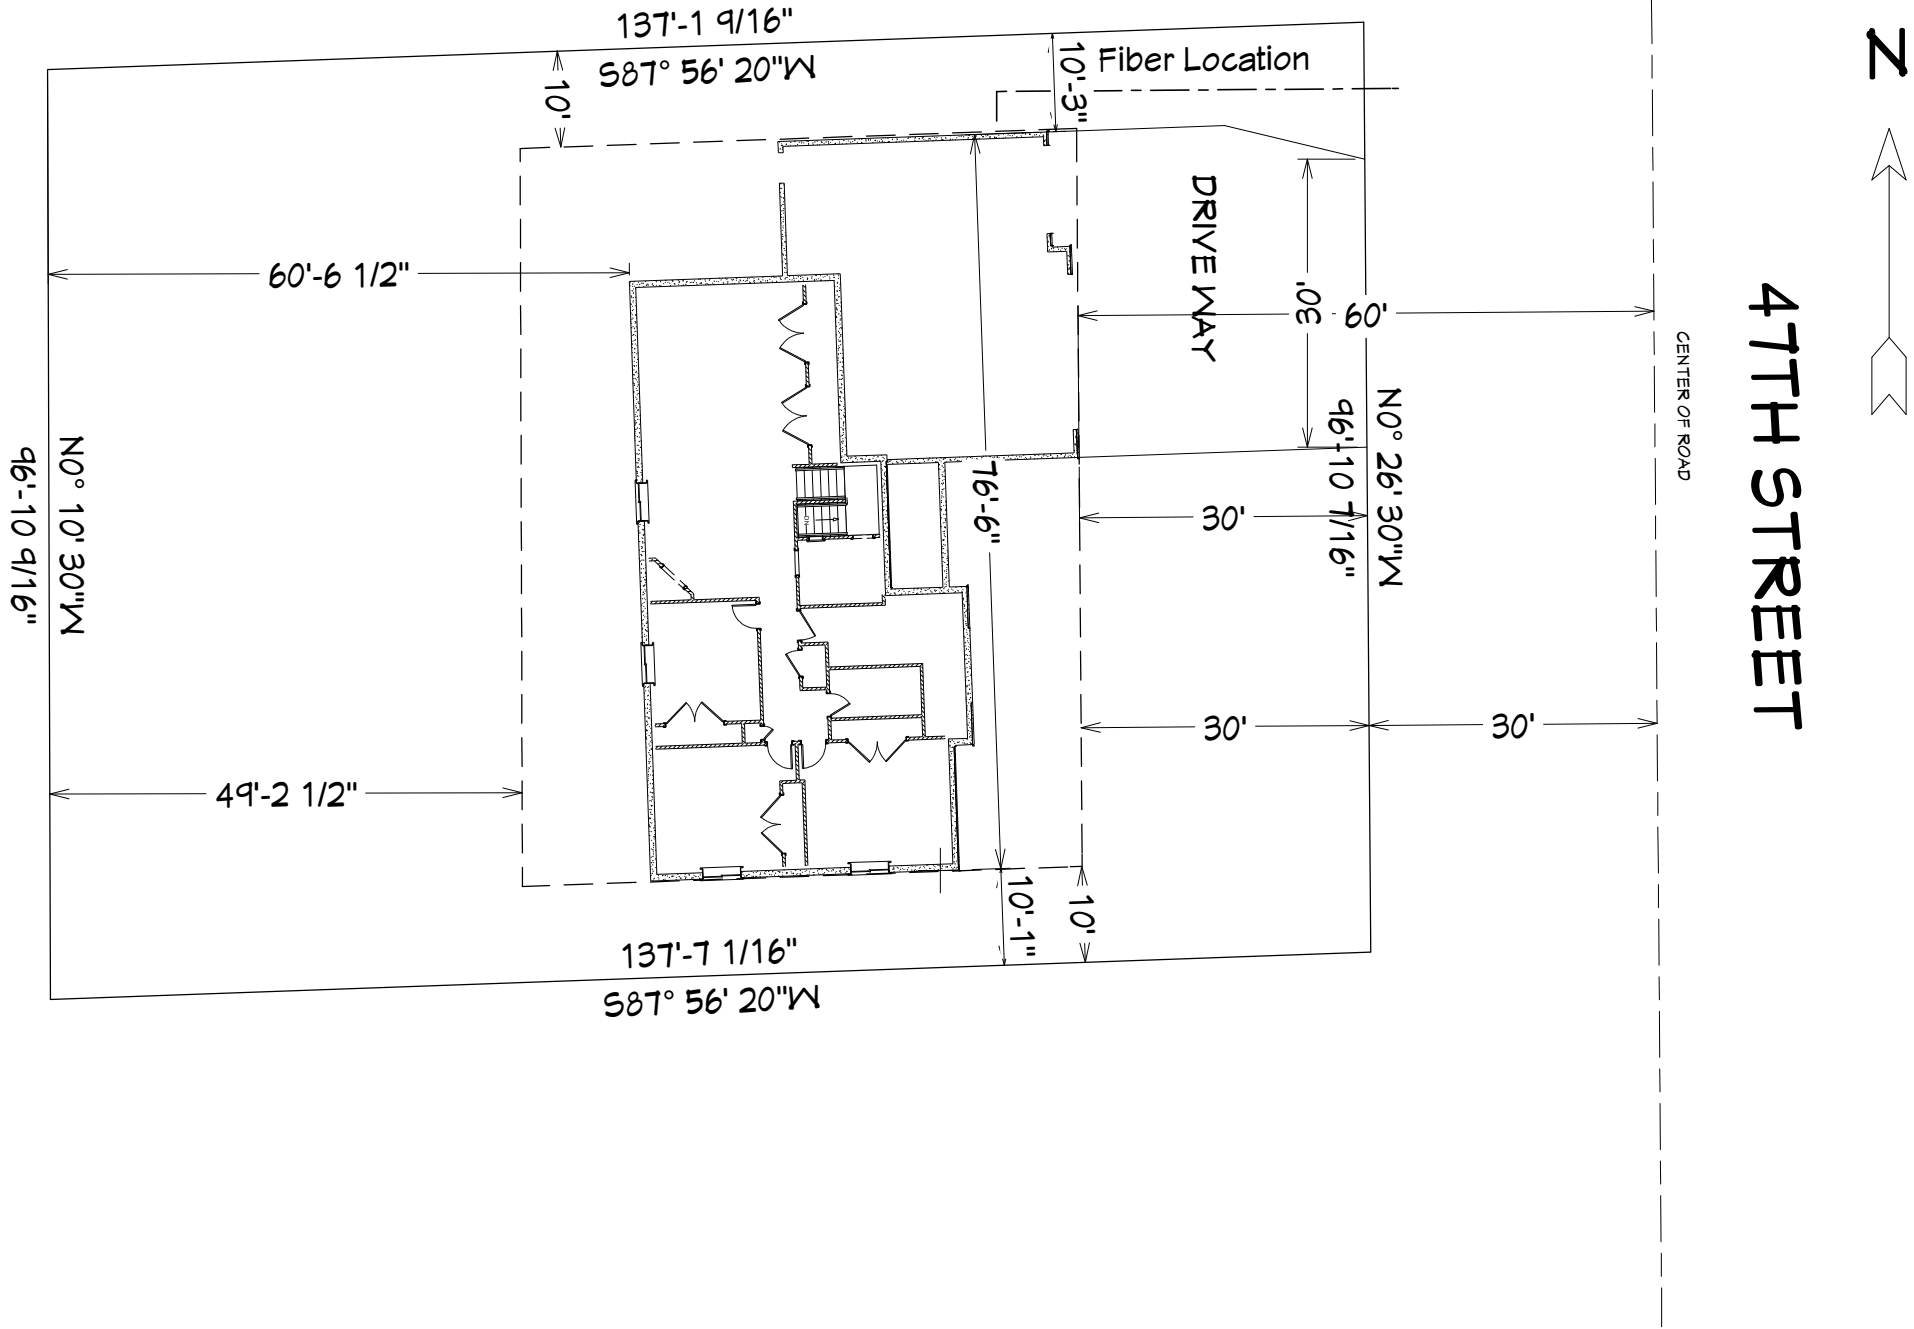

Main floor: 1798 sf
Foundation: 1766 sf
Basement: 1569 sf
Basement finished: 1426 sf
Front Porch: 78 sf
Garage: 877 sf

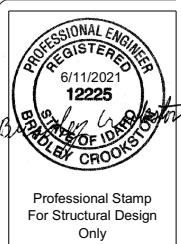

Contractors/Sub-Contractors to verify all finish work with contract. Plans as drawn may represent future options and possible finished layout. Extent of Finish as dictated by Sales Contract supersedes drawing representations.



NO.	DESCRIPTION	BY	DATE
1	Construction Set	B/C	4/15/2021
2	Construction Set	B/C	4/26/2021
3	Construction Set	B/C	5/10/2021
4	Construction Set	B/C	6/11/2021

SHEET TITLE:
Plot Plan

PROJECT DESCRIPTION:
Park Home (1952 47TH Street)
L11, B9, D4 The Villas
Ammon, Idaho

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North Logan, Utah 84341
Phone: 435-757-2906

JOB #
21020

SCALE:
1" = 10'

SHEET:
10